


SURFACE WATER SCHEME - FOR FOUL WATER SEE ADJACENT VIEW
SCALE 1:200

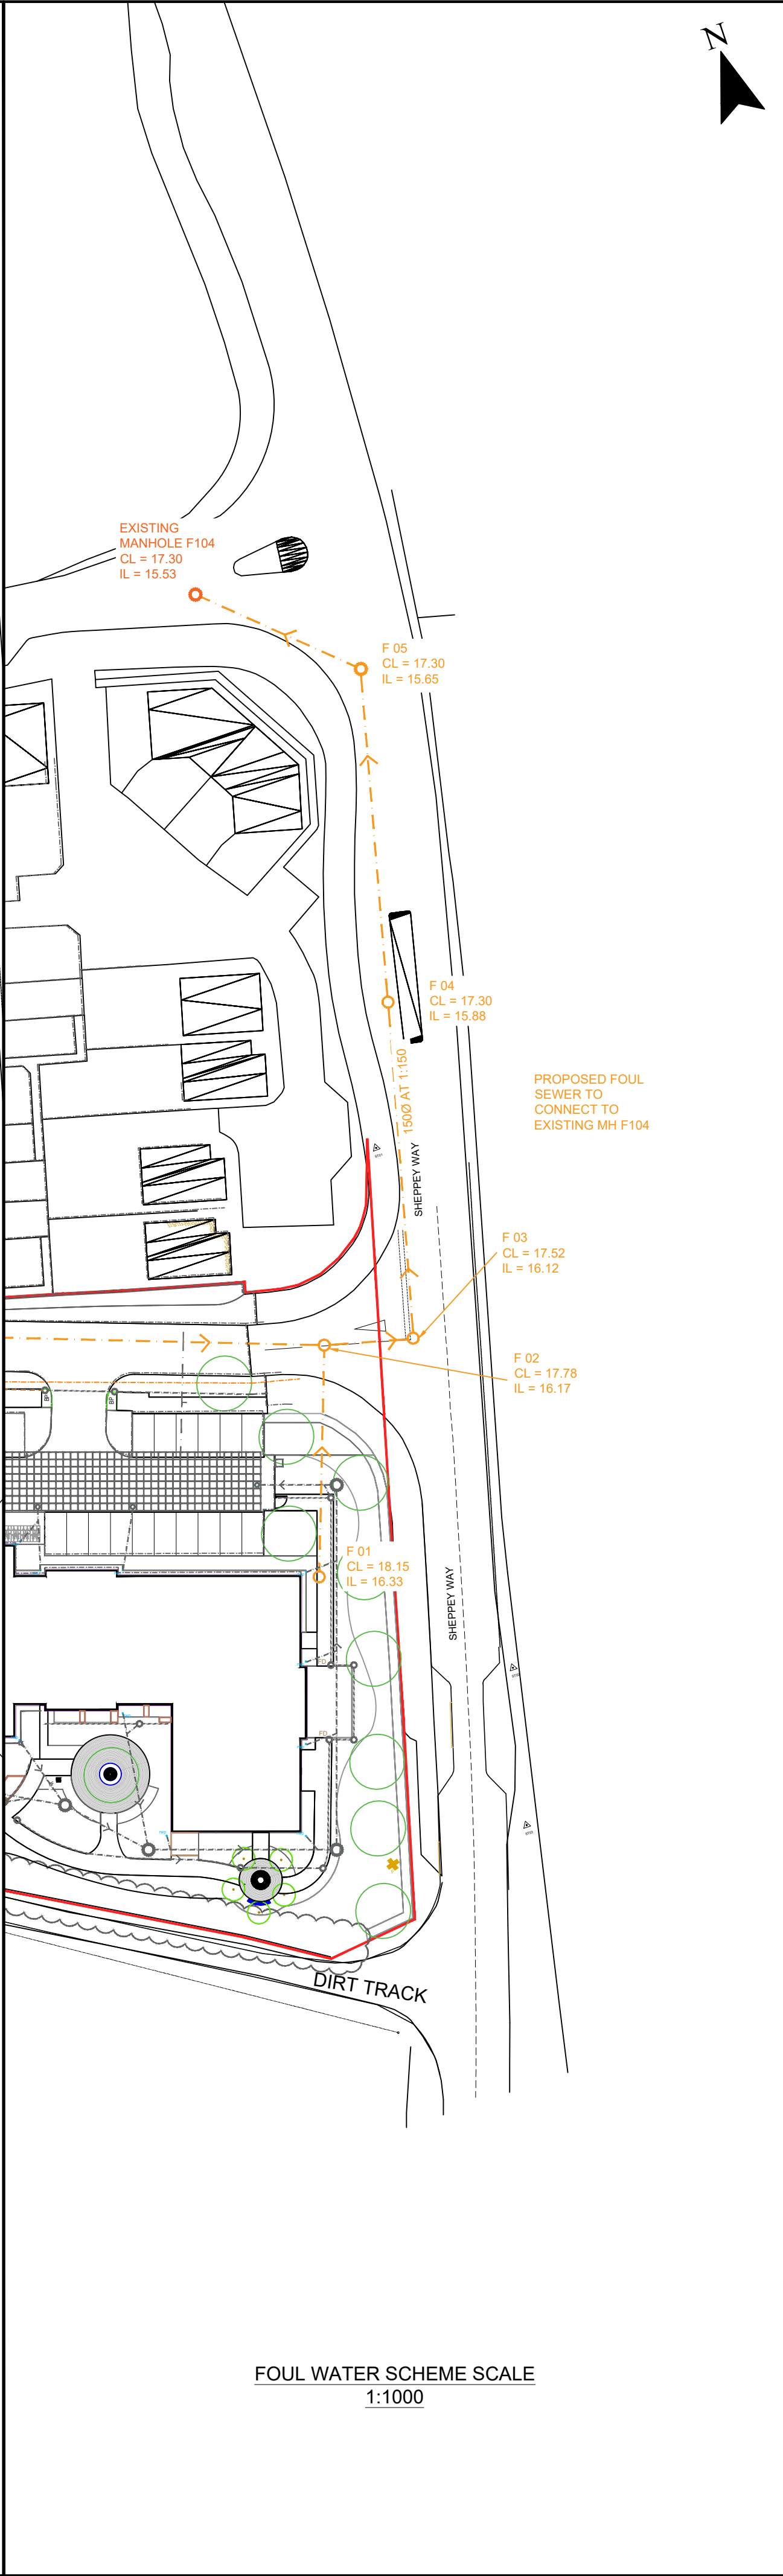

FOUL WATER SCHEME SCALE
1:1000

NOTES

- ALL LEVELS INDICATED ARE TO OS DATUM (METRES) FROM PROPOSED LEVELS RECEIVED.
- DRAINS TO BE LAID IN CLASS 'S' BEDDING WHERE COVER IS GREATER THAN 1200mm, WHERE DEPTH OF COVER IS LESS THAN 1200mm WITHIN TRAFFICKED AREAS A CONCRETE BED AND SURROUND SHALL BE PROVIDED.
- CONNECTIONS ARE TO BE CROWN TO CROWN. MANHOLE INVERT LEVELS REPORTED ARE TO THE DISCHARGE PIPE.
- NATIONAL GRID REFERENCE: X 590000 Y 167067.

LEGEND

- PROPOSED SURFACE WATER MANHOLE
- PROPOSED SURFACE DRAINAGE
- EXISTING FOUL WATER MANHOLE
- PROPOSED FOUL WATER MANHOLE
- PROPOSED FOUL DRAINAGE

P0	MC	IMR	JAN 21	PRELIMINARY ISSUE
Revision	By	Chk'd By	Date	Comments

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Site
IWADE

Project
DRAINAGE STRATEGY

Drawing Title
ACCESS ROAD DRAINAGE PLAN

Scale SEE INDIVIDUAL VIEWS	Date JANUARY 2021
Drawing Number 002	Revision P0

PRELIMINARY

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