

LEGEND

- Existing LV
- Proposed LV Mains
- Proposed LV Service
- Site Boundary/Phases
- Building Line
- Street Lighting

SINGLE PHASE SERVICE POSITIONS OUTDOOR
SCALE: NTS

Overall size: 408mm (w) x 595mm (h) x 210mm (d)
Brickwork opening: 365mm (w) x 535mm (h) x 150mm (d)
External meter box to be supplied by client
(Cables must not be routed through wall cavity)
Meter cabinet must be non-metallic
Available from most builders merchants and online

600A METER ARRANGEMENT INTERNAL

LV METER CABINET
HDCC
Duct rises flush with wall
1800 MIN.
250
255
700
2000 MAX.
1800 MAX.
450 MIN.
50
450 MIN.

Project overview

The provision of new LV metered supplies to serve the development at Sheppy Way, Iwade.

Supply Capacity / Load Calculation Basis

The ADMD for the site is 276 kVA based on a total of

14 residential properties @ 1.9kVA single phase
1 No Care Home supplies @ 249kVA three phase

All mains and sub mains have been sized to comply with cable thermal constraints on the basis of Summer Sustained ratings ducted.

Volt drop, Prospective Short Circuit Current (Ph-N), and ELI have been calculated for all key points on the system using WinDebut V3.1 and in accordance with the adopting networks Design requirements and the results shown. In all cases, the design complies with the max / min parameters stated in the design manual(s).

LV Point of Connection

The points of connection is at LV as advised by SSE in offer ref ERZ861/2 on 18th November 2020 and marked up GIS plan with the same date.

LV Cable

The LV mains cable will be 300mm² & 95mm² 3 core & Al waveform cable.

All LV mains cables will be laid direct unless otherwise stated. There shall be tile/caution tape to ENATS 12-23 installed as shown on cable sections detailed on this drawing.

Material specification

See DPFOR02 for detailed materials specifications.

Mains Ducts

Where used, cable ducts to be black twin walled corrugated ridgiduct to ENATS 12-24 embossed "electric cable duct" on opposing sides. Sizes are 150mm internal diameter unless otherwise stated in cross sections.

Service Ducts

Where used, services cable ducts to be black twin walled corrugated ridgiduct to ENATS 12-24 embossed "electric cable duct" on opposing sided. Size 32mm ID (37mm OD).

Supply Exit Points & Metering

The supply exit points for the 14 plots shall be the outgoing terminals of the single phase cutouts located within the external meter box at each property.

The supply exit point for the Care Home shall be the outgoing terminals of the heavy duty cutout located within the ground floor plant room.

Earthing

All properties will be supplied with TNC-S (PME) earthing system.

Civil Works

All on-site civil works associated with on-site cabling to be undertaken by others in accordance with the design supplied by HVSS.

All off-site civil works associated with cabling to be undertaken by HVSS/




Pulling Tensions

300mm ² 3c Al Waveform	400kg
95mm ² 3c Al Waveform	200kg
35mm ² 1c Al XLPE/PVC concentric	manual

Minimum Bending Radii

300mm ² 3c Al Waveform	950mm
95mm ² 3c Al Waveform	650mm
35mm ² 1c Al XLPE/PVC concentric	115mm

1no. care home with an ASC no greater than 249kVA will be fed via a HDCC c/w CT Cabinet terminating at an approved GF location.

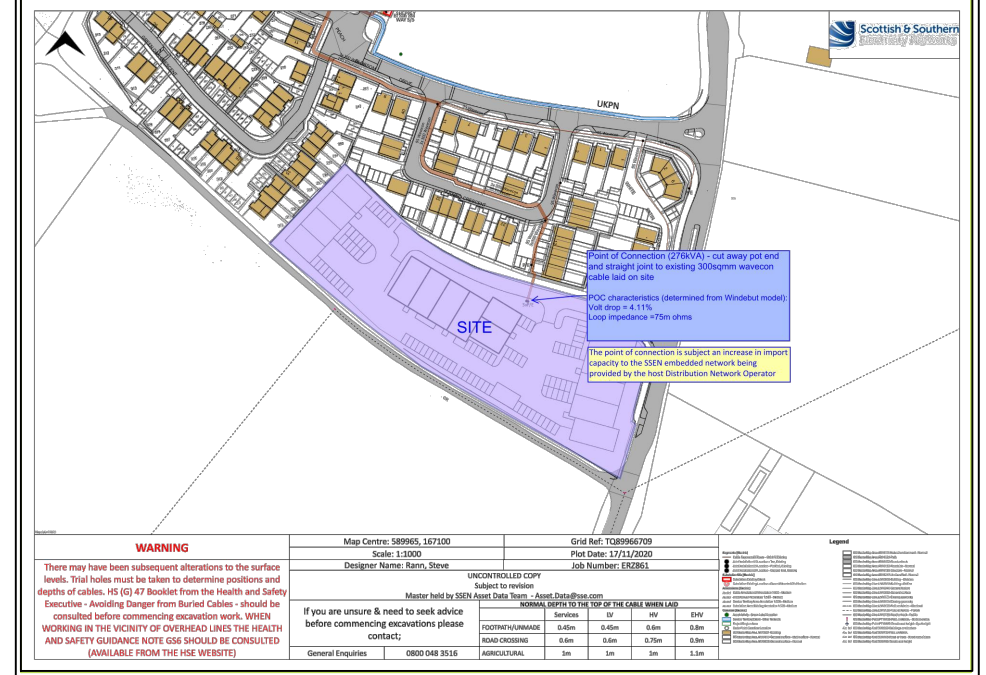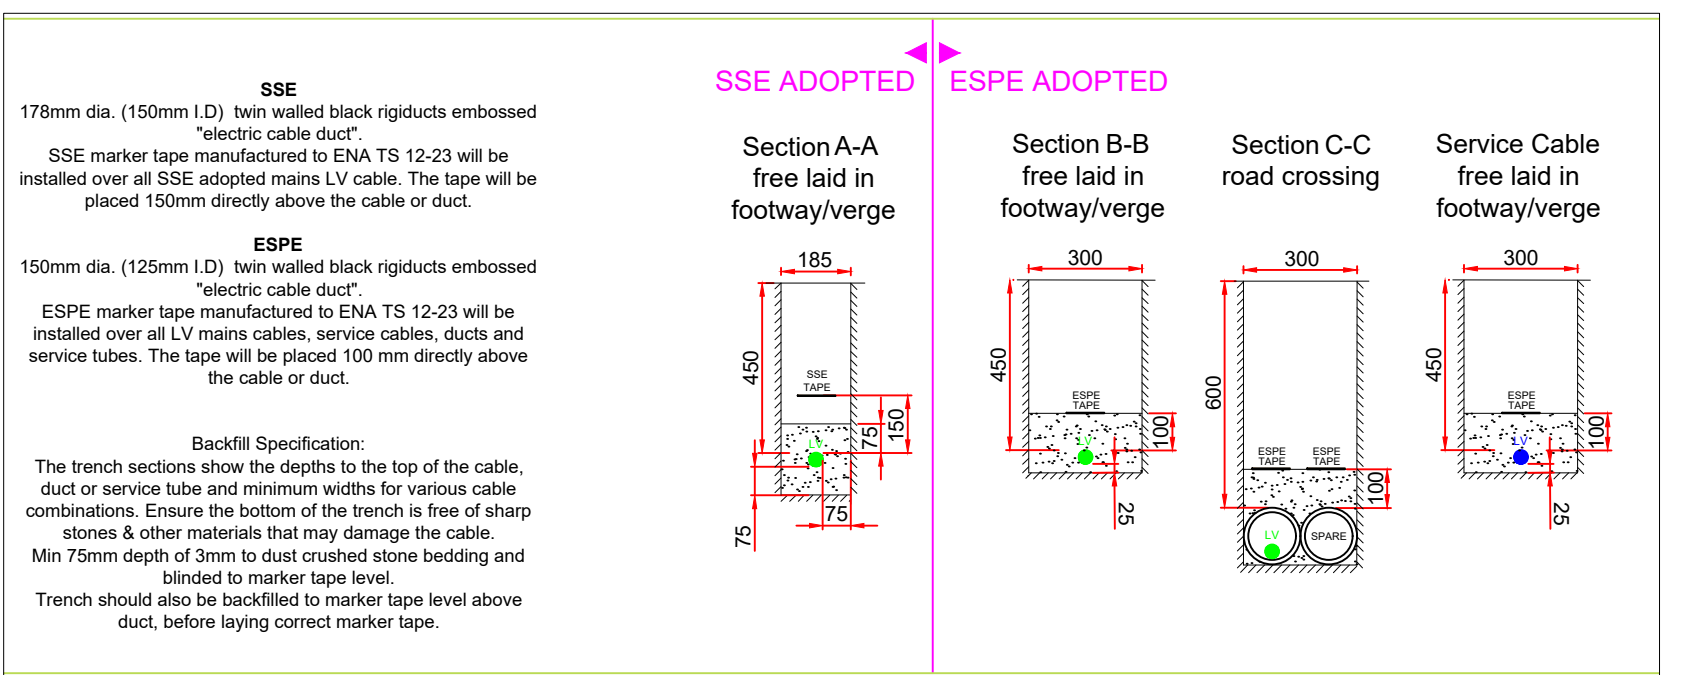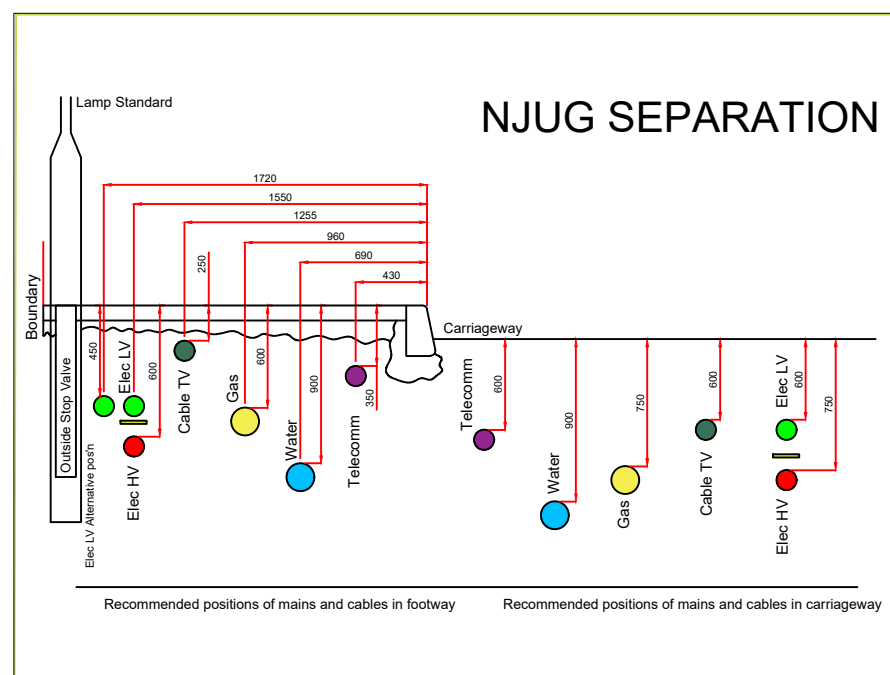

0	Original Issue	11/12/20	RUB	RUB	AB	AB
Rev	Amendment	Date	Des	Drw	Chk	App

APPROVED FOR CONSTRUCTION

HIGHVOLTAGE
SYSTEMS & SERVICES

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Client: **Frontier Estates**

Project Name: **Sheppy Way, Iwade**

Drawing Title: **Cable Route Plan**

Site Address: **Sheppy Way
Iwade
Sittingbourne
ME9 8GN**

Design Engineer: **Russ Burns** Mobile: **07807 232 464**

Project Manager: **Rachel Nead** Mobile: **07719 512 511**

IDNO Ref: **ESPE031660** Scale @ Size: **1:300 @ A1** Sheet: **1/1**

DNO Ref: **ERZ861/2** Project No: **P2021310** Drawing No: **010**