


SURFACE WATER SCHEME - FOR FOUL WATER SEE ADJACENT VIEW
SCALE 1:200

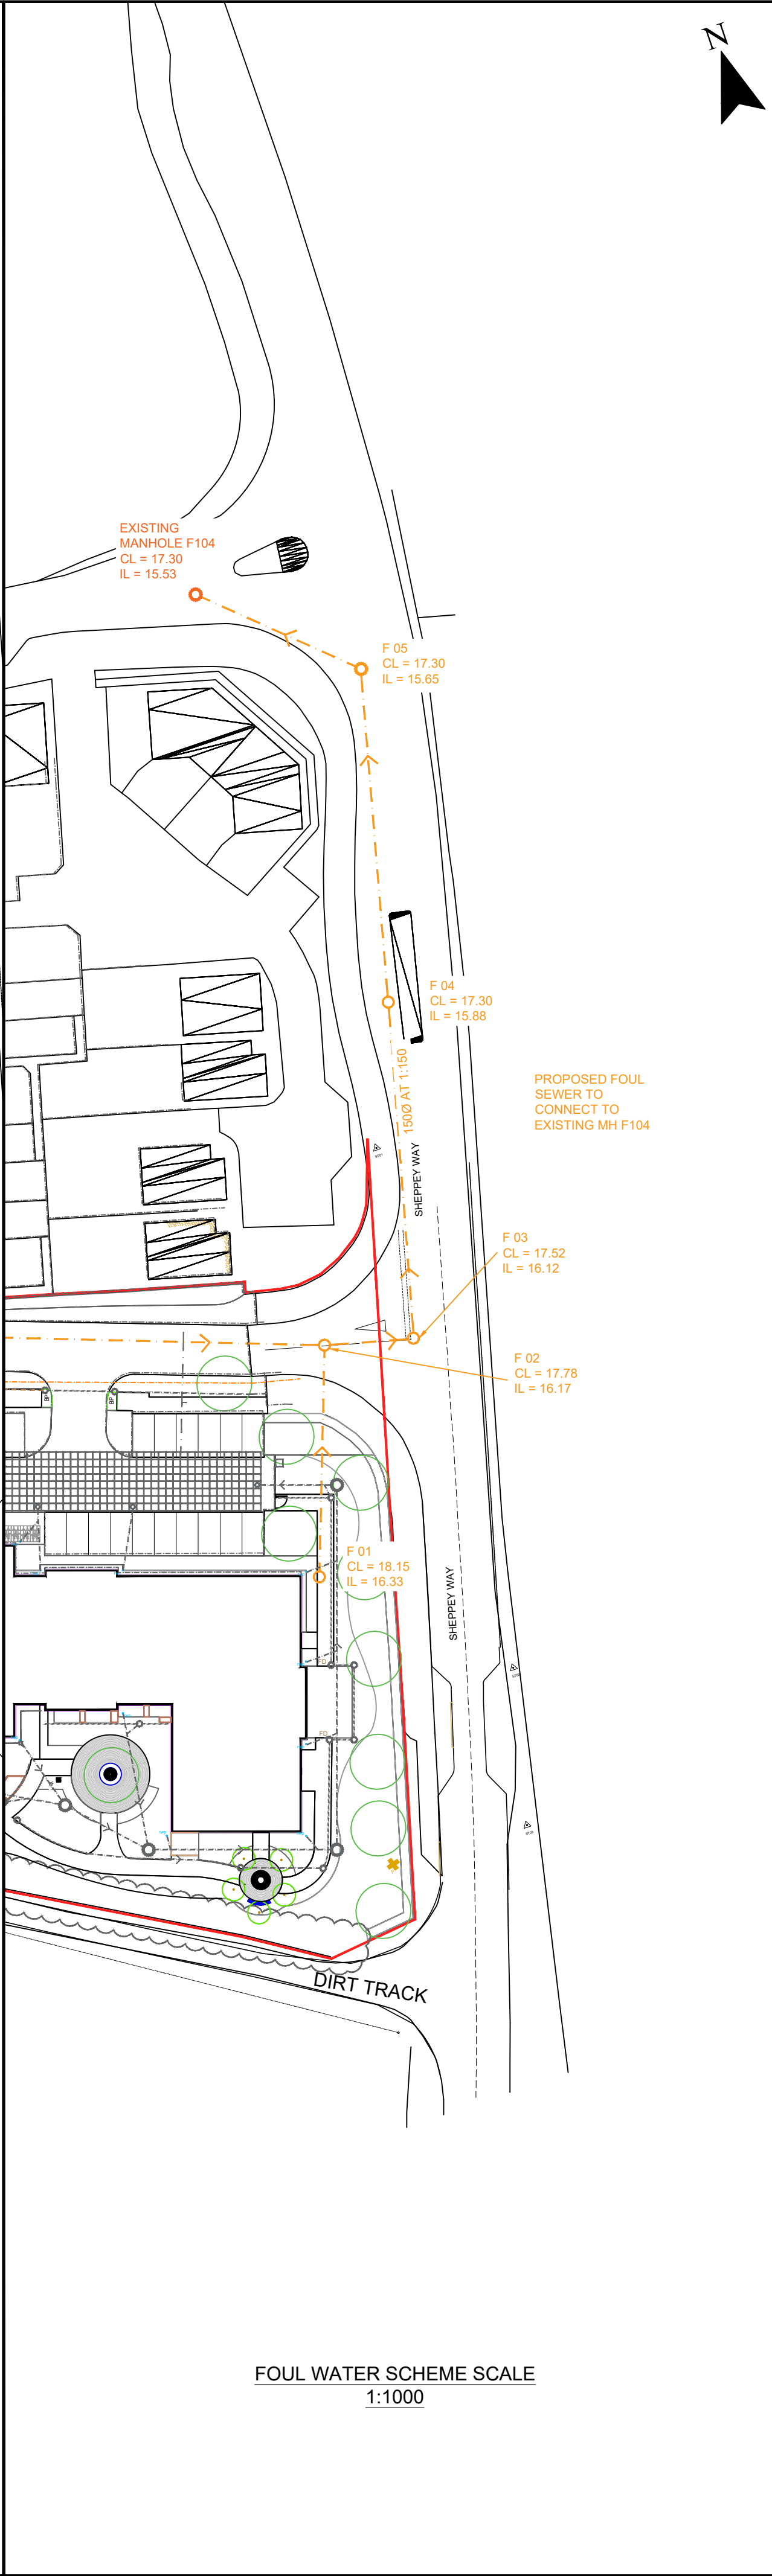

FOUL WATER SCHEME SCALE
1:1000

NOTES

1. ALL LEVELS INDICATED ARE TO OS DATUM (METRES) FROM PROPOSED LEVELS RECEIVED.
2. DRAINS TO BE LAID IN CLASS 'S' BEDDING WHERE COVER IS GREATER THAN 1200mm, WHERE DEPTH OF COVER IS LESS THAN 1200mm WITHIN TRAFFICKED AREAS A CONCRETE BED AND SURROUND SHALL BE PROVIDED.
3. CONNECTIONS ARE TO BE CROWN TO CROWN. MANHOLE INVERT LEVELS REPORTED ARE TO THE DISCHARGE PIPE.
4. NATIONAL GRID REFERENCE: X 590000 Y 167067.

LEGEND

- PROPOSED SURFACE WATER MANHOLE
- PROPOSED SURFACE DRAINAGE
- EXISTING FOUL WATER MANHOLE
- PROPOSED FOUL WATER MANHOLE
- PROPOSED FOUL DRAINAGE

P0	MC	IMR	JAN 21	PRELIMINARY ISSUE
Revision	By	Chk'd By	Date	Comments

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Site
IWADE

Project
DRAINAGE STRATEGY

Drawing Title
ACCESS ROAD DRAINAGE PLAN

Scale
SEE INDIVIDUAL VIEWS

Date
JANUARY 2021

Drawing Number
002

Revision
P0

PRELIMINARY

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